
FIXTURE SCHEDULE:


TYPE	LIGHT FIXTURE DESCRIPTION	FIXTU
А	SURFACE MOUNTED FIXTURE. 48-INCH LENGTH. 52.3-INCH OVERALL LENGTH .	
	53.4 WATTS LED. 8,000 LUMENS, 4000K COLOR TEMPERATURE. 80CRI. 120 VOLTAGE. MARINE RATED.	
	CAST & EXTRUDED ALUMINUM CONSTRUCTION WITH WHITE CORROSION RESISTANT FINISH AND	
	FLAT POLYCARBONATE FROSTED LENS, .125-INCH. STAINLESS STEEL HARDWARE. 0-10 DIMMING DRIVER.	
	MEDIUM DISTRIBUTION. COLD WEATHER, 6W INTERNAL EMERGENCY DRIVER, -20-CELSIUS MINIMUM.	
	10kV SURGE PROTECTION DEVICE 120-277V.	
	LITHONIA: FEX-L48-8000LM-FPFL-MD-120-GZ10-40K-80CRI-BE6WCP-SPD10KV-DWHXD CR	
В	WALL MOUNTED EXTERIOR FIXTURE. 13.33-INCH LENGTH x 8.75-INCH HEIGHT. 20 WATTS LED. 807 LUMEN	
	4000K COLOR TEMPERATURE. 82CRI. 120 VOLTAGE. MARINE RATED. ONE PIECE INJECTION MOLDED UV	
	STABILIZED POLYCARBONATE CONSTRUCTION WITH POLYESTER BRONZE FINISH POWDER COAT.	
	UV STABILIZED PRISMATIC POLYCARBONATE OPAL LENS. STAINLESS STEEL TORX HEAD SCREWS.	
	NON-DIMMING DRIVER. OVAL HORIZONTAL EYELID.	
	LUMINAIRE LED: AOV13HO YOVH NODIM 20W 40K 120 OP BRZ	

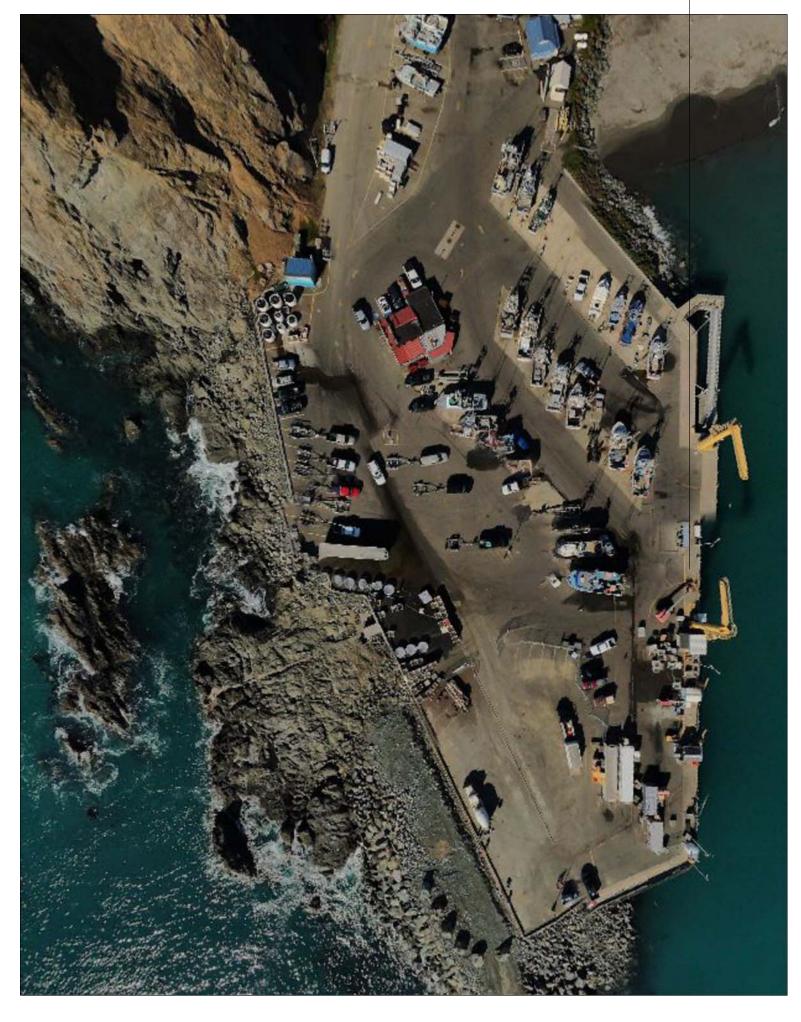

SCOPE OF WORK

PORT OF PORT ORFORD - Port Orford, Oregon

Google Earth Aerial Image - NTS

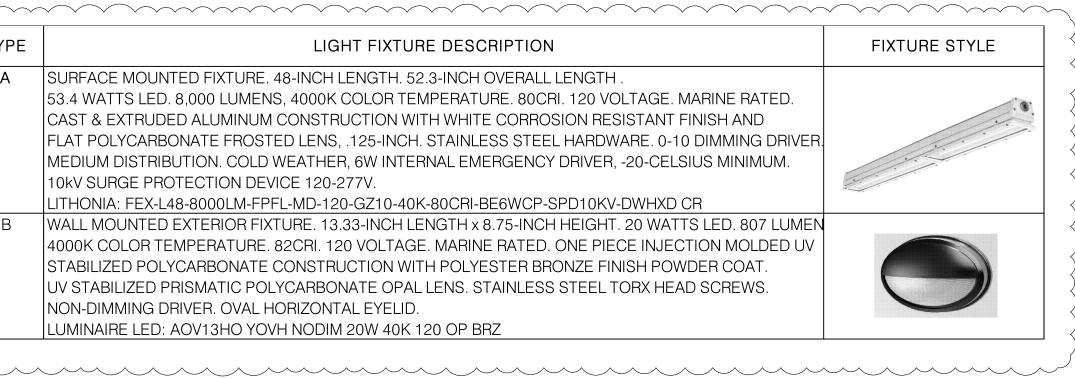

SYMBOL SCHEDULE:

\bigcirc	SURFACE MOUNTED FIXTURE WITH
—— G -——	GROUND CONDUCTOR
	UNDERGROUND CONDUIT SYSTEM
	EXPOSED CONDUIT SYSTEM
0	CONDUIT SYSTEM STUB UP
•	CONDUIT SYSTEM STUB DOWN

ABBREVIATIONS:

А	AMP
AF	AMPERES FRAME
AFC	AVAILABLE FAULT CURRENT
AFG	ABOVE FINISHED GRADE
AP	ACCESS POINT
АT	AMPERES TRIP
AWG	AMERICAN WIRE GAUGE
С	CONDUIT
DT	DRY TYPE
(E)	EXISTING
G	GROUND
GFCI	GROUND FAULT CIRCUIT INTERRUF
kAIC	KILO AMPERE INTERRUPTER CURRE



INDEX OF DRAWINGS: E-100 ELECTRICAL COVER SHEET E-200 ELECTRICAL SITE PLANS E-300 ELECTRICAL DETAILS E-400 ONE LINE POWER RISER DIAGRAM REPLACEMENT CRANE ORFORD TON TH OUTLET → WALL MOUNTED DUPLEX RECEPTACLE 20 SPECIAL PURPOSE CONNECTION 🖓 NON-FUSED DISCONNECT ORT ORFORD $\langle \mathbf{X} \rangle$ denotes sheet number Ā DENOTES BRANCH CIRCUIT "HOME RUN" LL 0 DENOTES NEUTRAL - DENOTES PHASE/SWITCH LEG ORT $\overline{\mathbf{O}}$ S T ER Ζ 0 B Ŭ kCMIL KILO CIRCLE MIL LCP LIGHTING CONTROL PANEL ELECTRIC 000 0 LIGHT POLE LP 74353. NOT TO SCALE NTS ш OVERHEAD ОН ິ ΡE PHOTO ELECTRIC DEVICE PHASE AND/OR NEUTRAL P/N POWER Powr PVC POLYVINYL CHLORIDE Know what's **below**. **Call** before you dig. ΤYΡ TYPICAL 02/20/2025 VOLTS \vee JPTER WP WEATHERPROOF RENT #XP, #XG PHASE AND GROUND CABLE AWG DESIGNED: PA CHECKED: PA **APRIL 25, 2024** 74353.000 \triangle 02/20/2025 DESIGN CLARIFICATION CUNDIFF SHEET ID **E-100**

ENGINEERING, INC. / CONSULTING ENGINEERS 10700 S.W. BEAVERTON-HILLSDALE HWY, STE 65 BEAVERTON, OREGON 97005 PH 503,521,7260, FX 503,521,7257 PROJECT NUMBER: 23-050

SHEET 15 OF 18